


**FRONT ELEVATION SCALE - 1:100** 

**SECTION THROUGH A - A'** SCALE: 1:100

**SECTION THROUGH B - B'** SCALE: 1:100

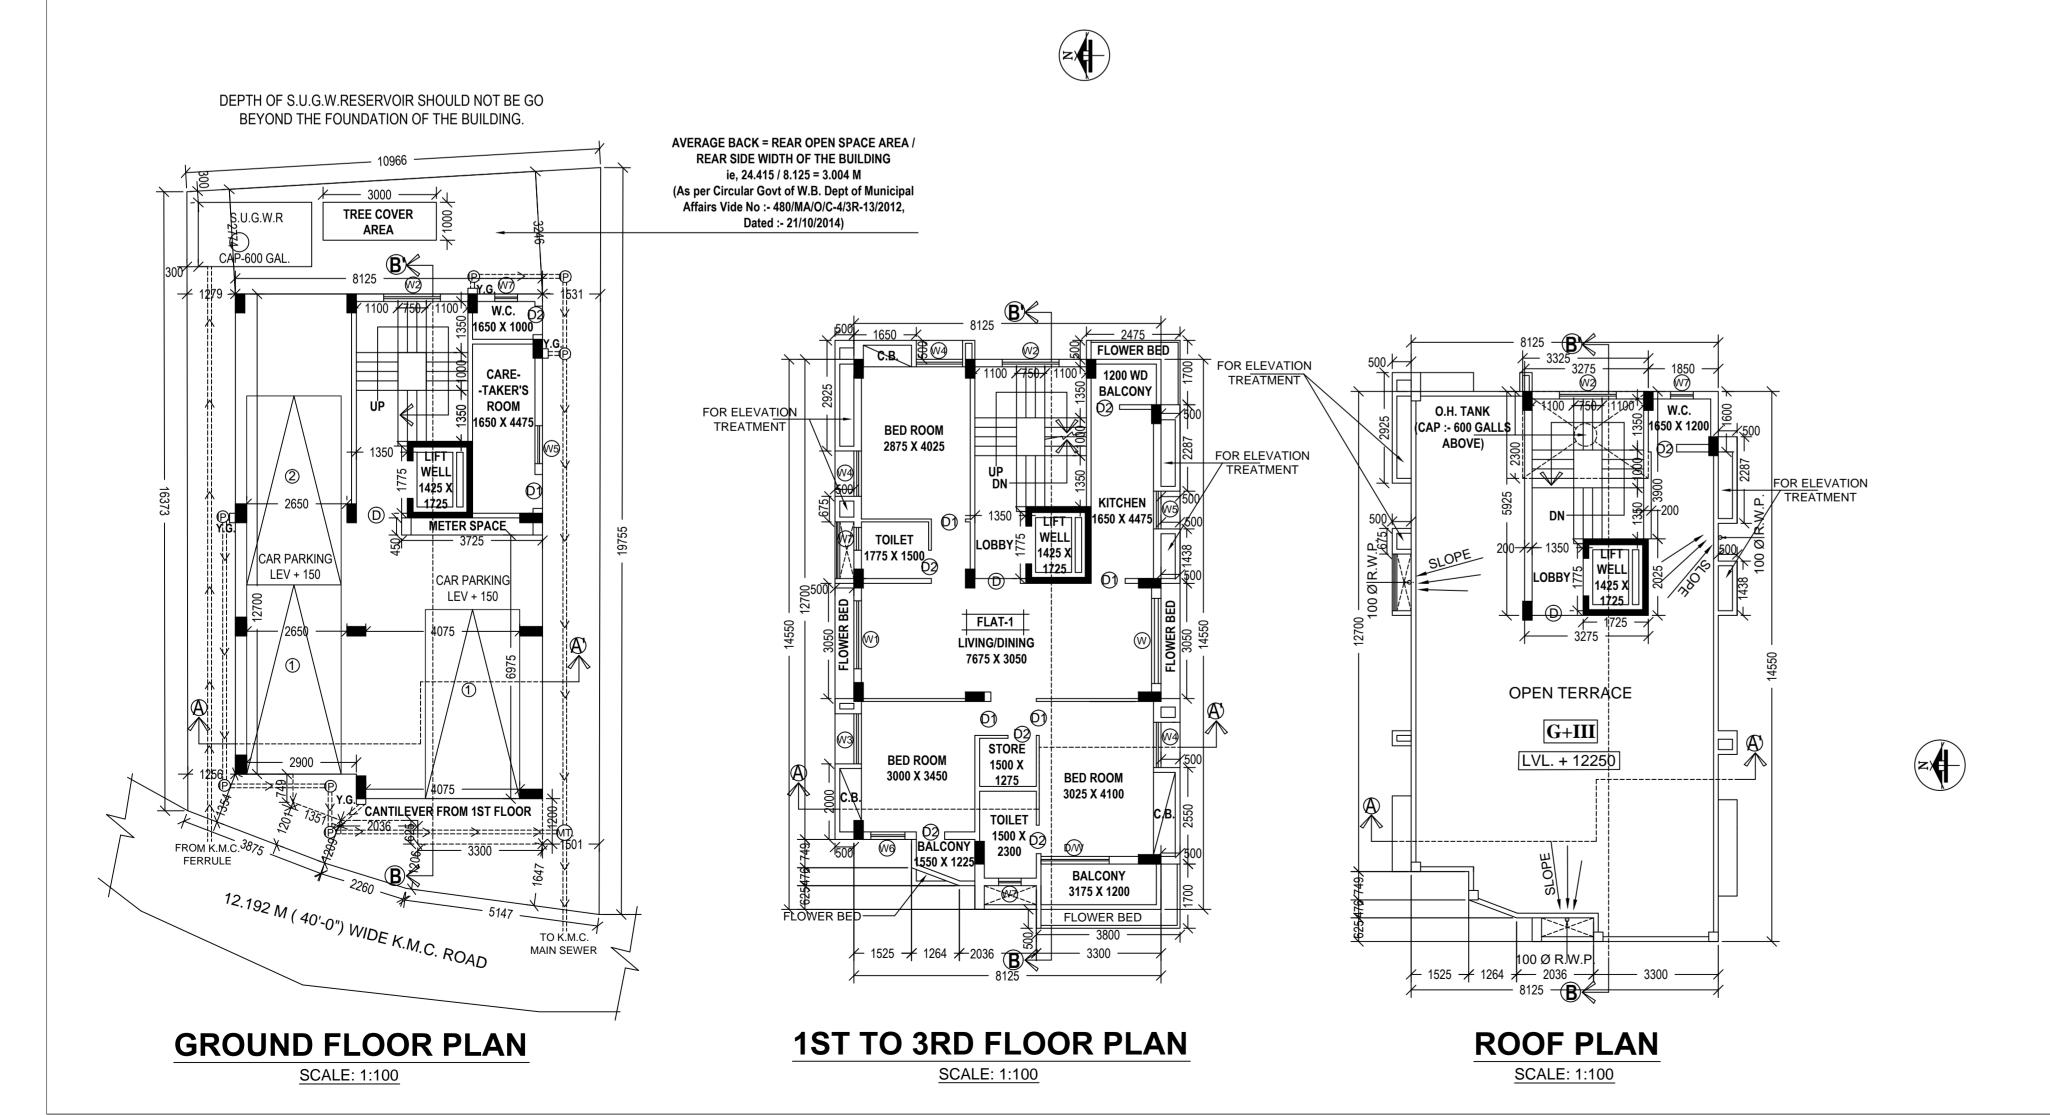

CERTIFICATE OF GEO - TECHNICAL ENGINEER

UNDERSIGNED SHALL INSPECTED THE SITE AND CARRIED OUT SOIL INVESTIGATION THEREON. IT SHALL BE ASCERTAINED THAT THE EXISTING SOIL OF THE SITE IS ABLE TO CARRY THE LOAD COMING FROM THE PROPOSED CONSTRUCTION AND THE FOUNDATION SYSTEM PROPOSED HEREIN IS SAFE & STABLE IN ALL RESPECT FROM GEO-TECHNICAL POINT OF VIEW.

> RUPAK KUMAR BANERJEE B.C.E, M.E., M.I.G.S, M.I.E. CHARTERED ENGINEER G.T.E. - 3(I)

NAME OF GEO-TECHNICAL ENGINEER

CERTIFICATE OF STRUCTURAL ENGINEER

THE STRUCTURAL DESIGN OF BOTH FOUNDATION AND SUPERSTRUCTURE OF THE BUILDING HAVE BEEN MADE BY ME CONSIDERING ALL POSSIBLE LOADS INCLUDING THE SEISMIC LOAD AS PER N.B.C OF INDIA. CERTIFY THAT IT IS SAFE AND STABLE IN ALL RESPECT.

DOOR WINDOW SCHEDULE						
TYPE	WIDTH	HT.	TYPE	WIDTH	HT.	JOYDEEP MUKHERJEE  B.E. (CIVIL), E.S.E 178(I)  NAME OF STRUCTURAL ENGINEER
D	1200	2150	W	2250	1800	
D1	900	2150	W1	1800	1800	
D2	750	2150	W2	1500	1800	DECLARATION OF ARCHITECT
D/W	1800	2150	W3	1325	1800	CERTIFIED THAT THE PLAN ITSELF WITH FULL RESPONSIBILITY THAT THE BUILDING PLAN HAS DRAWN UP AS PER PROVISION OF K.M.C. BUILDING RULES 2009, AS AMENDED FROM TIME TO TIME AND THE SITE CONDITION INCLUDING THE ABUTTING ROAD IS CONFORM WITH THE PLAN. IT IS A BUILD ABLE SITE NOT A TANK OR FILLED UP TANK.
			W4	1200	1800	
			W5	1000	1000	
			W6	900	1800	
			W7	600	750	

R.C.C. FRAME STRUCTURE WITH CONC. GRADE 1:1.5:3. 200 M.M. THK. EXTERNAL 125 & 75 M.M. THK. INTERNAL WALLS WITH

1:4 CEMENT MORTER JOINTS. STEEL Z- SECTION WINDOWS.

**SPECIFICATIONS** 

CAST-IN-SITU MARBLE FLOORING.

(ii) PROPOSED GROUND COVERAGE

5. PROPOSED HEIGHT

(v) OVER HEAD TANK AREA

(vi) AREA OF W.C. AT ROOF

(vii) AREA OF CUP-BOARD

(viii) AREA OF TREE COVER

(ix) TOTAL AREA FOR FEES

6. PROPOSED AREA

1:6 & 1:4 CEMENT PLASTER ON INTERNAL WALLS AND CEILING RESPECTIVELY

WATER PROOFING TREATMENT. P.O.P. PUNNING ON INTERNAL WALLS & CEILING.

ARJUN PAL (B.ARCH) Registered Architect STATEMENT OF THE PLAN PROPOSAL Regn No - CA/2010/47578 NAME OF ARCHITECT. PART-A: 1. ASSESSE NO: 110723401288 DECLARATION OF OWNER

2. DETAIL OF REGISTERED DEED . I DO HERE BY DECLARE WITH FULL RESPONSIBILITY THAT, I SHALL ENGAGE BOOK NO : I VOL. NO : 1602-2022 PAGE NO : 508601 TO 508630 L.B.A & E.S.E DURING CONSTRUCTION. I SHALL FOLLOW THE INSTRUCTION OF L.B.A & E.S.E DURING CONSTRUCTION OF THE BUILDING (AS PER PLAN) PLACE: D.S.R.-II SOUTH 24-PARGANAS BEING NO: 160213533 DATED: 04.11.2022 K.M.C AUTHORITY WILL NOT BE RESPONSIBLE FOR STRUCTURAL STABILITY VOL. NO: 1602-2022 PAGE NO: 521793 TO 521826 OF THE BUILDING & ADJOINING STRUCTURE. IF ANY SUBMITTED DOCUMENT BEING NO: 160213972 DATED: 14.11.2022 PLACE: D.S.R.-II SOUTH 24-PARGANAS ARE FAKE THE K.M.C AUTHORITY WILL REVOKE THE SANCTION PLAN. THE VOL. NO: 1602-2022 BOOK NO: I PAGE NO: 581667 TO 581697 CONSTRUCTION OF S.U.G.W.R TAKEN UNDER THE GUIDANCE OF L.B.A/E.S.E BEING NO: 160215960 DATED: 08.12.2022 PLACE: D.S.R.-II SOUTH 24-PARGANAS BEFORE STARTING OF BUILDING FOUNDATION. 3. DETAIL OF REGISTERED BOUNDARY DECLARATION

THE PLOT IS IDENTIFIED BY ME. THE PLOT IS FULLY DEMARCATED BY BOUNDARY WALL. THERE IS NO TENANT. THERE IS NO COURT CASE BOOK NO : I VOL. NO: 1602-2023 PAGE NO: 214720 TO 214733 PENDING AGAINST THIS PLOT. BEING NO: 160206665 DATED: 16.05.2023 PLACE: D.S.R. - II SOUTH 24-PARGANAS 4. a) AREA OF LAND (Deed & Physical) : 3K-00CH-00SFT = 200.668 SQM b) NO OF STOREY 5. a) NO. OF TENAMENTS : 3 NOS.

59.977 % = 120.354 SQM

56.330 % = 113.037 SQM

: b) 100.0 - 200.0 Sqm ..... 03 NOS **6. SIZE OF TENAMENTS** PART-B: 1. AREA OF LAND AS PER TITLE DEED = 3K-00CH-00SFT = 200.668 SQM 2. AS PER BOUNDARY DECLARATION = 3K-00CH-00SFT = 200.668 SQM 3. NET LAND AREA = 200.668 SQM 4. (i) PERMISSIBLE GROUND COVERAGE

MR. JAYANTA MAZUMDAR PARTNER OF M/S. J.G. ADVISORY LLP NAME OF OWNER / APPLICANT

DIGITAL SIG. OF ASSISTANT ENGINEER (K.M.C.)

BR. VIII / BUILDING DEPARTMENT

PLAN CASE NO. - 2023080031

B.P. NO :- 2023080030 DATED :- 22-06-2023 VALID UPTO :- 21-06-2028 GROSS COVERED AREA STAIR DUCT LIFT WELL STAIR+STAIR LOBBY LIFT LOBBY NET FLOOR AREA 10.165 SQ.M 2.396 SQ.M 93.83 SQ.M 113.037 SQM 2.458 SQ.M 10.165 SQ.M 0.75 SQ.M 113.037 SQM 0.75 SQ.M 2.458 SQ.M 10.165 SQ.M 2.396 SQ.M 97.268 SQ.M 3RD FLOOR 113.037 SQM 0.75 SQ.M 2.458 SQ.M 10.165 SQ.M 2.396 SQ.M 97.268 SQ.M TOTAL 445.502 **SQM** 2.25 **SQ.M** 7.374 **SQ.M** 40.660 SQ.M 9.584 SQ.M 385.634 SQ.M 7. TENEMENTS & CAR PARKING CALCULATION

(A) RESIDENTIAL: MARKED TENEMENT SIZE PROPORTIONAL AREA TO BE ACTUAL TENEMENT AREA NO. OF TENEMENT REQUIRED CAR PARKING 120.362 SQ.M

= 12.250 MT.

1 96.01 SQ.M 24.352 SQ.M (B) PARKING: GROUND FLOOR PLAN, FIRST TO THIRD FLOOR PLAN, ROOF PLAN, (i) TOTAL REQUIRED CAR PARKING :- 3 NOS :- 3 NOS (ii) TOTAL PROVIDED CAR PARKING (iii) PERMISSIBLE AREA FOR PARKING = 75.0 SQ.M. (iv) PROVIDED AREA OF PARKING = 74.794 SQ.M. 8. **F.A.R.:** (i) PERMISSIBLE F.A.R BOROUGH NO.-VIII, P.S. - BHAWANIPUR, KOLKATA - 700 025 (ii) PROPOSED F.A.R = (385.634 - 74.794) / 200.668 = 1.549<2.25 9. MISC AREA: (i) STAIR HEAD ROOM AREA :- 16.084 SQ.M 2/2 (ii) LIFT MACHINE ROOM AREA (M.R.L.)
(iii) TERRACE AREA

- 7.648 SQ.M.

:- 2.96 SQM.

:- 9.3 SQM.

:- 3.00 SQM.

- 467.715 SQM

FRONT SIDE ELEVATION, SECTION AT A-A', B-B' PROPOSED G+III STORIED (HT.-12.250MT.) RESIDENTIAL BUILDING U/S 393 A OF K.M.C. ACT 1980 & UNDER BUILDING RULE 2009 AT PREMISES NO - 130/1/1A, RAJ SEKHAR BOSE SARANI, WARD NO.-72,

JOB NO. DRG. NO. ARCH / CORP - A DWG :- 3.493 SQ.M :- 113.037 SQ.M. (iv) RELAXATION OF AUTHORITY, IF ANY :- N.A.



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14.06.2023

AYAN